CAPIZZI LAW OFFICES

11 Hillside Ave., Second Floor Tenafly, NJ 07670

MATTHEW G. CAPIZZI, ESQ. N.J., N.Y., & D.C. Bars

201 266 8300 (o) 201 266 8301 (f) Capizzilaw.com

New York Office: 1 Blue Hill Plaza Lobby Level, Suite 1509 Pearl River, NY 10965 Reply to New Jersey Office

June 29, 2021

Initial Submittal for Completeness Review

Via Overnight Mail

Maureen Oppelaar – ZBA Secretary 930 River Road New Milford, NJ 07646

Re:

203 Main Street Property LLC – New Milford ZBA (the "Applicant")

203 Main Street; Block 1304, Lot 5 (the "Property")

Dear Ms. Oppelaar:

As you know, we represent the above Applicant regarding its variance application before the New Milford Zoning Board of Adjustment seeking variances relative to the renovation and expansion of the existing building to provide for the following uses: (1) 1st Floor: Divide the 1st Floor into three suites consisting of a commercial suite for use as a retail business or restaurant, a one-bedroom apartment, and a two-bedroom apartment and (2) 2nd Floor: 4 two-bedroom apartments. To that end, enclosed please find the following:

- 1. Notice of Appeal Zoning Board of Adjustment with Rider attached thereto (17 copies);
- 2. Borough of New Milford Zoning Work Sheet with Letter of Denial dated June 8, 2021 attached thereto (17 copies);
- 3. Block Diagram (17 copies);
- 4. Seepage Pit Design prepared by dated as of April 20, 2021 (17 copies);
- 5. Engineering Plan prepared by Azzolina & Feury Engineering, Inc., dated as of April 20, 2021 and last revised as of May 11, 2021 consisting of two (2) sheets (17 copies);
- 6. Architectural Plan prepared by Canzini Architects dated as of May 4, 2021 and last revised as of May 19, 2021 consisting of three (3) sheets (17 copies); and
- 7. Applicant's W9 and checks:
 - Check # 1001 in the amount of \$200.00 (Application Fee)
 - Check # 1002 in the amount of \$1,500.00 (Escrow Fee).

Maureen Oppelaar – ZBA Secretary June 29, 2021 Page 2 of 2

Kindly advise when this matter has been deemed complete and assigned a hearing date before the New Milford Zoning Board of Adjustment.

Thank you.

Very truly yours,

Gloria Duby

MGC/gd Enclosures

Application	#	
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NOTICE OF APPEAL ZONING BOARD OF ADJUSTMENT BOROUGH OF NEW MILFORD, BERGEN COUNTY, NJ 07646

Propert	y Address 203	Main Stree	t, New Milford I	NJ 07646		Subject to	Sale agree	ment (YES NO)
			_ Zone (Resi		siness Tow	nhome – ot	her)
			resent use (Re					
Owned	Leased - If	property is	s within 200' o	f Borough li	ne name ad	jacent mun	icipality(le	s) <u>N/A</u>
Name of	Owner 203 M	lain Street F	Properties LLC			Te	lephone	()
			m above)					
Name of	Applicant (if	not homeov	wner) <u>203 Mai</u>	n Street Prop	erties LLC o			
			ue, 2nd Floor,		17.			mber 201-266-8300
Name of	Attorney Mat	thew G. Car	pizzi, Esq.					iding Meeting Yes
			A.I.A	Ph	one Numbe	201-265- or: 201-845-	5645 Atten	ding Meeting Yes anding Meeting: Yes
Name of I	Engineer: Perr	y Frenzel, F ner hereby	'.E. seeks relief fr		(a)			of the New Milford
_	Ordinance.	-25 1/aV/11)(a), 30.25.1(g)	(2)(3), and 3	ດ 28 1(e)(1)	(2)	m denial lo	
The prope	seed applicati	on is contr	ary to the ordi	nance in the	: IOHOWIDE 1	72 9(3). De	specific at	tach a separate sheet if
necessary	. (What you a	re proposi:	ng and why it	violates the :	zoning orai	цапсе).		
See attach	ed Rider.							
							(e):	
1	Lot Area	Front	Right Side	Left Side	Corner	Rear	Height	Building Coverage
Required	7,500 sq.ft.	0.0'	0.0'	0.0'	N/A	10.0'	30'	1,000 Sq. Ft.
Existing	N/A	0.6'		0.1'	N/A	11.7'	16.8'	4,180 Sq. Ft.
Proposed	<u>n/a</u>	0.8	50.0'	<u>0.1'</u>	-N/A	11.7'	34.6'	4,432 Sq. Ft.
Difference	<u>n/a</u>	(
Driveway \	Width Requ	ired <u>N/A</u>	_ Existing	Prop	osed	Curb Cu	t [Y/N]\$	Size
Are trees b	eing removed	YESONO	How many	Sh	ade Tree (Commissio	n date app	roved
	f Applicant _	61			>	E	ate 6/	19/2021
	- 8		thew G. Capiz	zi, Esq.			Title Applic	cant's Attorney

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11 Hillside Ave., Second Floor Tenafly, NJ 07670 MATTHEW G. CAPIZZI, ESQ. 201 266 8300 (o) N.J., N.Y., & D.C. Bars 201 266 8301 (f) Capizzilaw.com

> New York Office: 1 Blue Hill Plaza Lobby Level, Suite 1509 Pearl River, NY 10965 Reply to New Jersey Office

> > June 29, 2021

Rider to Notice of Appeal

Via Overnight Mail

Chairman N. Ari Weisbrot and Members of the Board Borough of New Milford 930 River Road New Milford, NJ 07646

Re: 203 Main Street Properties, LLC – New Milford ZBA (the "Applicant")

203 Main Street; Block 1304, Lot 5 (the "Property")

Dear Mr. Chairman Weisbrot and Members of the Board:

This office represents the above Applicant regarding its application before the New Milford Zoning Board of Adjustment (the "Board"). The Property is improved with a one-story building that was a former restaurant. The Applicant seeks to renovate and expand the existing building to provide for the following uses:

1st Floor: Divide the 1st Floor into three suites consisting of the following:

- 1. 1,976 Sq. Ft. commercial suite for use as a retail business or restaurant containing 32 seats;
- 2. a one-bedroom apartment; and
- 3. a two-bedroom apartment.

2nd Floor

1. 4 two-bedroom apartments

To permit the renovations and expansions, the Applicant is before the Board seeking Site Plan Approval and bulk variances as to Minimum Size of Residential Units (700 sf for one-bedroom and 900 sf for two-bedrooms Minimum Required v. 655 sf for one-bedroom and 844 sf for two-bedrooms Proposed) and Minimum Off-Street Parking if

Chairman Weisbrot and Members of the Board June 29, 2021 Page 3 of 3

the first-floor unit is used as Retail Use (26 Required¹ v. 20 Proposed). If the first floor is used as a restaurant, the combination of restaurant and apartment uses <u>does not</u> require a variance as to off-street parking as the site will provide 20 parking spaces where 20' are required².

Thank you.

Very truly yours,

Matthew & Capizzi, Esq.

MGC/gd

¹ Retail - 1 space per 150 sf/1976 = 13.17 parking spaces; 5 two-bedroom and 1 one-bedroom = 12 parking spaces for a total of 25 parking spaces

² Restaurant - 1 space per 4 seats/32 seats = 8 parking spaces; 5 two-bedroom and 1 one-bedroom = 12 parking spaces for a total of 20 parking spaces

BOROUGH OF NEW MILEORD ZONING WORK SHEET

190	930 River Road, New Milford, NJ 07646 - (201) 967-8172 fax (201) 967-1741	\$65.00 Fee	=
	930 River Road, New Milford, NJ 07646 - (201) 967-8172 fax (201) 967-1741 203 Main Street Properties, LLC One-story addition retail/apartments		
Owner	c/o Matthew G. Capizzi, Esq. Proposed Project on the first floor and Corner Property	ty YES[]	NO [X]
	apartments on the second floor		
Job Loc	tation 203 Main Street, New Milford NJ 07646 Phone Number 201-266-8300		

INSTRUCTIONS Please fill in the zoning work sheet in the spaces where applicable based on your construction project. Include a copy of your survey with your project sizes, dimensions and setback figures drawn on it. You are certifying the below figures are true.

copy of your survey when you	ii project sizes, aimensions ai	na setback jigures arawn on it. You a	re certifying the below figures are true.
Setback Requirements			
Sheds/Detached Garages	5' from rear & side yard	(Sheds 9' high, Garages/ Gazebos 1	5' high)
Pools	6' from rear & side yard	(everything associated with pool, su	
IN GROUND POOLS -	Two typography site plans	are required & \$500 escrow deposit	
Drainage retention systems		vith the new zero run off law, to be d	
			block & within (200') feet of either side
lot line or 30 feet if no buildi	ing exists within $(200')$ feet 8	$oldsymbol{\emptyset}$ measured in a direction parallel to $oldsymbol{\emptyset}$	the street on which the lot faces. For
	ject please i nclude front yar		
Rear yard setback		num if your lot is less than 100' deep.	
Side yard setback		nore of the front width of your prope	erty
		less front width of your property	
Corner setback	30' setback		
Height		ne average of four corners from the g	
Story -	Where the basement ceilin	g is at least 3 feet above the average	finished grade along any side of the
building the basement shall	count as one story.		
SETBACK WORKSHEET			
	L.5) (Include separate front y	ard worksheet for all porches, portic	os) Variance Needed
Requirement 0.0'		6' Proposed 0.8'	
Rear Yard Setback (30-21.		Proposed o.o	Yes [] No [x]
Requirement 10.0'	•	.7' Proposed 11.7'	Yes [] No [x]
Right Side Yard Setback (3	30-21.5c)		
Requirement 0.0'	-	Proposed <u>50.0'</u>	Yes [] No [X]
Left Side Yard Setback (30			
Requirement 0.0'	-	1' Proposed 0.1'	Yes [] No []
Corner Setback (30-21.5c)	1 & c2)		
Requirement 30'	Existing N/	A Proposed N/A	Yes [] No []
Height (30-21.6)			
Requirement 30'	Existing <u>16</u>	.8'Proposed 34.6'	Yes [] No [x]
Stories (30-21.6) & definiti	on of story		
Requirement 2 ½ storie	s Existing 1	Proposed <u>2</u>	Vec [] No[v]
Maximum Building Cover	age Requirements determ	nined by lot size (30-21.4)	
		SQ. FT. ←Your requirement (A) N/A
		requirement	, , , , , , , , , , , , , , , , , , ,
Maximum Total Impervio	us Coverage Requirement	ts (30-21.4)	
		SQ. FT. ←Your requirement (_(B) N/A
	-		-,

	(SQUARE	FEET)	(SQUARE F	-	REMARKS
BUILDING FOOTPRINT	4,180 S	q. Ft	4,432 S	q. Ft.	
DETACHED GARAGE	N/A		N/A		
ROOFED PORCHES, PATIOS AND BREEZEWAYS	N/A		N/A		
STORAGE SHEDS	N/A		N/A		
OTHER ACCESSORY BULDINGS	N/A		N/A		
DRIVEWAYS AND PARKING AREAS	8,668 Sc	ą. Ft.	8,416 Squ	are Ft.	
OPEN PORCHES, TERRACES, PATIOS AND DECKS	N/A		N/A		
STEPS AND WALKWAYS	N/A		N/A		
SWIMMING POOLS	N/A		N/A		
OTHER IMPERVIOUS SURFACES	N/A		N/A		
(ADD ITEMS 1 THROUGH 5)	4,180	S.F.	4,432	S.F.	DIVIDE THE TOTAL SQUARE FOOT
TOTAL IMPERVIOUS COVERAGE					AREA BY THE LOT AREA TO
(ADD ITEMS 1 THROUGH 10)	100			S.F.	DETERMINE % OF COVERAGE
	ROOFED PORCHES, PATIOS AND BREEZEWAYS STORAGE SHEDS OTHER ACCESSORY BULDINGS DRIVEWAYS AND PARKING AREAS OPEN PORCHES, TERRACES, PATIOS AND DECKS STEPS AND WALKWAYS SWIMMING POOLS OTHER IMPERVIOUS SURFACES TOTAL BUILDING COVERAGE (ADD ITEMS 1 THROUGH 5)	ROOFED PORCHES, PATIOS AND BREEZEWAYS STORAGE SHEDS OTHER ACCESSORY BULDINGS DRIVEWAYS AND PARKING AREAS OPEN PORCHES, TERRACES, PATIOS AND DECKS STEPS AND WALKWAYS SWIMMING POOLS OTHER IMPERVIOUS SURFACES (ADD ITEMS 1 THROUGH 5) TOTAL IMPERVIOUS COVERAGE	ROOFED PORCHES, PATIOS AND BREEZEWAYS STORAGE SHEDS OTHER ACCESSORY BULDINGS DRIVEWAYS AND PARKING AREAS OPEN PORCHES, TERRACES, PATIOS AND DECKS STEPS AND WALKWAYS SWIMMING POOLS OTHER IMPERVIOUS SURFACES (ADD ITEMS 1 THROUGH 10) N/A IN/A N/A 8,668 Sq. Ft. N/A N/A VA 4,180 S.F. % TOTAL BUILDING COVERAGE (ADD ITEMS 1 THROUGH 10)	ROOFED PORCHES, PATIOS AND BREEZEWAYS STORAGE SHEDS N/A OTHER ACCESSORY BULDINGS DRIVEWAYS AND PARKING AREAS OPEN PORCHES, TERRACES, PATIOS AND DECKS STEPS AND WALKWAYS SWIMMING POOLS OTHER IMPERVIOUS SURFACES (ADD ITEMS 1 THROUGH 10) N/A N/A N/A N/A S.F. 4,432 S.F. 12,848	ROOFED PORCHES, PATIOS AND BREEZEWAYS STORAGE SHEDS N/A OTHER ACCESSORY BULDINGS DRIVEWAYS AND PARKING AREAS OPEN PORCHES, TERRACES, PATIOS AND DECKS STEPS AND WALKWAYS SWIMMING POOLS OTHER IMPERVIOUS SURFACES (ADD ITEMS 1 THROUGH 10) N/A N/A N/A N/A N/A N/A S.F. 4,432 S.F.

		14//	I A/V		
10	OTHER IMPERVIOUS SURFACES	N/A	N/A		
11	TOTAL BUILDING COVERAGE	4,180 S.F.	4,432	S.F.	
	(ADD ITEMS 1 THROUGH 5)	%		%	DIVIDE THE TOTAL SQUARE FOOT
12	TOTAL IMPERVIOUS COVERAGE	S.F.	12,848	S.F.	AREA BY THE LOT AREA TO DETERMINE % OF COVERAGE
	(ADD ITEMS 1 THROUGH 10)	100 %	100	%	DETERMINE NOT COVERAGE
		uired 1.000 Sq. Ft uired 100%			
Side Ket	(3-3.2) (In ground, Above ground, Semi- quirement <u>6'</u> Existing	Proposed		Type of	pool:
Side Ket	quirement <u>6' Existing</u>	Proposed		Type of	the pool (filters, heaters, and walkwa) pool: ND[]ABOVE GROUND[] SEMI[]
The detection making to Survey a	quirement 6' Existing quirement 6' Existing exis	Proposed Pro	s not binding board or thr	on the ough the	pool: ND [] ABOVE GROUND [] SEMI [] Borough of New Milford. That ne judicial process, the applicant, if municipal estoppel.
The detection of the de	quirement 6' Existing quirement 6' Existing exis	Proposed Pro	s not binding board or thr	on the ough the	pool: ND [] ABOVE GROUND [] SEMI [] Borough of New Milford. That ne judicial process, the applicant, if municipal estoppel.
The determinating Survey a Homeow	quirement 6' Existing quirement 6' Existing exis	Proposed Pro	s not binding board or thr	on the ough the	pool: ND [] ABOVE GROUND [] SEMI [] Borough of New Milford. That



Borough of New Milford Department of Public Works

850 Robert K. Chester Way, New Milford, New Jersey 07646 Tel.: (201) 967-8172 Fax: (201) 967-1741 Mailing address: 930 River Road, New Milford, New Jersey 07646 VINCENT A. CAHILL, CPWM, CFM, CIS, CRP Director of Public Works Zoning Officer Property Maintenance Officer vcahill@newmilfordboro.com

SYL BRESA, CPWM SuperIntendent of Public Works Property Maintenance Officer sbresa@newmilfordbora.com

203 Main Street Properties LLC.C/O Capizzi Law Offices11 Hillside Avenue Second Floor Tenafly, New Jersey 07670

RE: 203 Main Street Block 1304 lot 12

Date: June 8, 2021

To whom it may concern

I have reviewed the plans drawn by Canzani Architects dated May 19, 2021. This letter is to inform you that the application is denied as it violates Borough codes 30-25.1(a)(11)(a) dwellings, 30.25.1(g)(2)(3) minimum size of residential units and 30-28.1(e)(1)(2) off street parking.

Appearance before the Zoning Board of Adjustment is required for a use variance, in addition to any other variances the Board may deem necessary.

If you wish to schedule a meeting with the Zoning Board, please contact Board Secretary, Maureen Oppelaar, at 201-967-5044 extension 5560.

If you have any questions, I can be reached at above email.

Respectfully,


Vincent A. Cahill, CPWM, CFM, CIS, CRP

mapale

Director of Public Works

Zoning Officer

Property Maintenance Officer

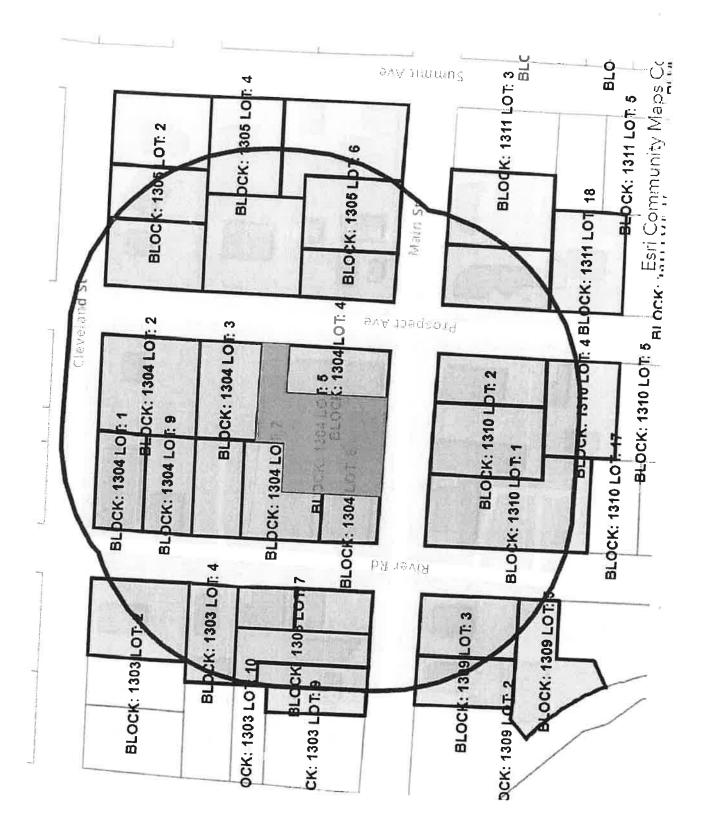

SEEPAGE PIT DESIGN

203 MAIN STREET PROPERTY LLC

203 MAIN STREET BLOCK 1304 - LOT 5 BOROUGH OF NEW MILFORD BERGEN COUNTY, NEW JERSEY FILE #12061

April 20, 2021

AZZOLINA & FEURY ENGINEERING, INC. CONSULTING ENGINEERS PARAMUS, NEW JERSEY

> Perry E. Frenzel, P.E. Professional Engineer N. J. Lic. #28190

203 MAIN STREET PROPERTY LLC

Block 1304 - Lot 5 203 Main Street Borough of New Milford Bergen County, New Jersey Prepared by: CDD Checked by: PEF Date: April 20, 2021

Job #12061

SEEPAGE PIT SYSTEM DESIGN

Drainage Area: 4,481 ft² (Impervious; Roof Area) C=0.98

5,308 ft² (Impervious; Driveway Area) C=0.98

<u>Design Storm:</u> 10 Year – 60 minute

2.0 in./hr. Intensity 2.0 in. of Total Rainfall

Volume of Runoff: $\{2.0 \text{ in.} / (12 \text{ in./ft.})\} \times 4,481 \text{ ft}^2 \times 0.98 = \frac{732 \text{ ft}^3}{2.0 \text{ in.}}$

 $\{2.0 \text{ in.} / (12 \text{ in./ft.})\} \times 5,308 \text{ ft}^2 \times 0.98 = 867 \text{ ft}^3$

Total = $1,599 \text{ ft}^3$

SEEPAGE PIT SYSTEM VOLUME

(3 Pits)


8.0 ft. Diameter, 3'-8" Deep 3.0' Stone Around, 2.5' Under (See Plan for Detail)

Pit Volume: $3(\pi R^2 H) = 3\{\pi(3.67^2)(3.0^3)\} = 381 \text{ ft}^3$

Volume of Stone under Pit: (WxLxH) x 40% Voids = $(14.0^{\circ}x42.0^{\circ}x2.5^{\circ})$ x 0.40 = 588 ft³

<u>Total Volume of Pit:</u> 381 + 642 + 588 =**1,611 ft**³

Storage Provided 1,611 ft³ > 1,599 ft³ Storage Required

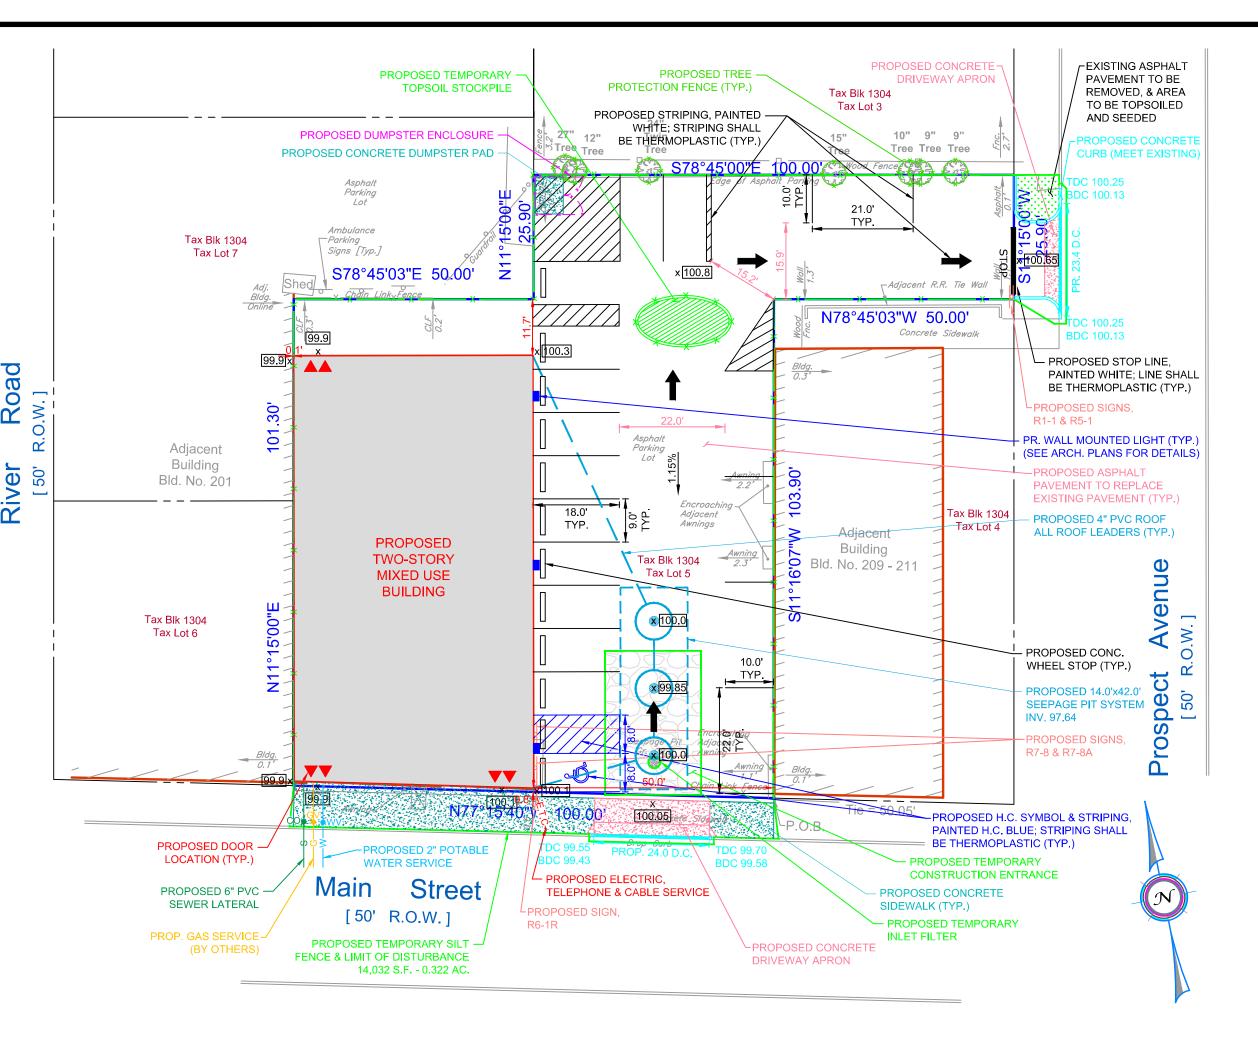

200' PROPERTY OWNERS LIST & LOCAL UTILITIES:

DANII YNN LLC

33 KING RD

KAHN CORNER LLC

194 MAIN ST

ESTELLE, CHARLES

BERGEN COUNTY PLANNING BOARD

HACKENSACK, NJ 07601-7076

UNITED WATER RESOURCES

HARRINGTON PARK, NJ 07640

TRENTON, NJ 08625-0439

HACKENSACK, NJ 07601

200 OLD HOOK RD

PO BOX 439

ONE BERGEN COUNTY PLAZA 4TH FLOOR

HACKENSACK RIVER KEEPER, [IF REQUIRED]

DEPARTMENT OF ENVIRONMENTAL PROTECTION, [IF REQUIRED]

228 MAIN ST

NEW MILFORD, NJ 07646 BLOCK 1311 - LOT 2	NEW MILFORD, NJ 07646 BLOCK 1309 - LOT 4	LANDING, NJ 07850 BLOCK 1303 - LOT 5 210 RIVER RD
WHITAKER, ANNEMARIE 200 SUMMIT AVE NEW MILFORD, NJ 07646 BLOCK 1305 - LOT 3	210 MAIN ST NEW MILFORD, LLC 7502 SECOND AVENUE NORTH BERGEN, NJ 07407 BLOCK 1310 - LOT 2 210 MAIN ST	MURPHY, JAMES F & SHANNON COX- 200 PROSPECT AVE NEW MILFORD, NJ 07646 BLOCK 1304 - LOT 2
ST JOSEPH'S COLUMBIAN CLUB INC. 199 RIVER RD NEW MILFORD, NJ 07646 BLOCK 1304 - LOT 1	WILSON, PATRICK L & HELEN C 375 RTE 94 SOUTH NEWTON, NJ 07860 BLOCK 1310 - LOT 4 232 PROSPECT AVE	KADEHJIAN, KEVORK V & NORA 240 CLEVELAND ST NEW MILFORD, NJ 07646 BLOCK 1305 - LOT 1
LAYNE, RONALD 251 MAIN ST NEW MILFORD, NJ 07646 BLOCK 1311 - LOT 1 222 MAIN ST	BRUTON, JOHN & MARY 201 RIVER RD NEW MILFORD, NJ 07646 BLOCK 1304 - LOT 9	BESHARA, MAGDI M & MONA BANOOB 231 PROSPECT AVE NEW MILFORD, NJ 07646 BLOCK 1311 - LOT 18
ABBAS, ALI MEHDI & SYEDA AFSHAN 205 PROSPECT AVE NEW MILFORD, NJ 07646 BLOCK 1305 - LOT 8	STUCKE, BRIAN & SUSAN ARMBRUSTER- 198 RIVER RD NEW MILFORD, NJ 07646 BLOCK 1303 - LOT 3	CARROLL, WALTER G & LILLIAN 1933 E QUIET CANYON DR TUSCAN, AZ 85718 BLOCK 1304 - LOT 4
NEW MILFORD VOLUNTEER AMBULANCE CORP 213 RIVER RD NEW MILFORD, NJ 07646 BLOCK 1304 - LOT 7	BOROUGH OF NEW MILFORD 930 RIVER RD NEW MILFORD, NJ 07646 BLOCK 1304 - LOT 8 RIVER RD	COOLSERV EQUIPMENT LLC 230 RIVER RD NEW MILFORD, NJ 07646 BLOCK 1309 - LOT 5
BERRY, THOMAS & BERRY, GEORGE & MARYLOU 600 LARCH AVE SADDLE BROOK, NJ 07662 BLOCK 1305 - LOT 7 223 MAIN ST	STAVROU FAMILY LLC 67 ORANGEBURG RD OLD TAPPAN, NJ 07675 BLOCK 1305 - LOT 6 227 MAIN ST	KAHN CORNER LLC 195 MAIN ST NEW MILFORD, NJ 07646 BLOCK 1303 - LOT 7
HATTEN, ANN L & TRSTES-LIV TRST 1114 ANDERSON AVE FORT LEE, NJ 07024 BLOCK 1305 - LOT 5 231-233 MAIN ST	LAMB, JR ROBERT D & FRANCES 204 PROSPECT AVE NEW MILFORD, NJ 07646 BLOCK 1304 - LOT 3	MITCHELL, ESTATE OF PAUL A 204 CLEVELAND ST NEW MILFORD, NJ 07646 BLOCK 1305 - LOT 2
STUCKE FAM TRUST/P & N TRUSTEES 206 RIVER RD NEW MILFORD, NJ 07646 BLOCK 1303 - LOT 4	LIU, HJ & JW C/O PARKWAY ASSET MGMT 233 MOORE ST SUITE 102 HACKENSACK, NJ 07646 BLOCK 1304 - LOT 5 203 MAIN ST	ORMENO, KAREN 189 MAIN ST NEW MILFORD, NJ 07646 BLOCK 1303 - LOT 8
214-216 MAIN STREET, LLC 7502 SECOND AVENUE NORTH BERGEN, NJ 07047 BLOCK 1310 - LOT 3	PENDELTON, ROBERT 204 SUMMIT AVE NEW MILFORD, NJ 07646 BLOCK 1305 - LOT 4	201 MAIN ST NM LLC C/O TOWN CLEANE 201 MAIN ST NEW MILFORD, NJ 07646 BLOCK 1304 - LOT 6
CASUAL HABANA LLC 125 MAIN ST HACKENSACK, NJ 07601 BLOCK 1310 - LOT 1 200 MAIN ST	LOW, DONALD W & KERRY E 190 MAIN ST NEW MILFORD, NJ 07646 BLOCK 1309 - LOT 3	KAHN CORNER LLC 194 MAIN ST NEW MILFORD, NJ 07646 BLOCK 1303 - LOT 6 197 MAIN ST

PSE&G COMPANY

CABLEVISION

PO BOX 9

40 POTASH ROAD

OAKLAND, NJ 07436

FOOT OF MEHRHOF ROAD

LITTLE FERRY, NJ 07643

BERGEN COUNTY UTILITIES AUTHORITY ERIC ANDERSEN, P.E., P.P., C.M.E.

252-254 STATE STREET

HACKENSACK, NJ 07601

BUILDING HEIGHT CALCULATION 99.9+99.9+99.9+99.9+100.1+100.2+100.3+100.0 = 800.2 / 8 = 100.0399.9 (F.F.) + 34.73' (F.F. TO RIDGE) = 134.63 PROPOSED RIDGE 134.63 (RIDGE) - 100.03 (GRADE PLANE) = 34.60' PR. BLDG. HT.

100.0 PROPOSED BUILDING × 100.2 F.F. 99.90 99.9

<u>LEGEND</u>

CLEAN OUT

SANITARY

WATER LINE WATER VALVE

GAS LINE

GAS VALVE

BUILDING

CURB

DEPRESSED CURB

SPOT ELEVATION

EXISTING

____ G ____

x 98.9

PROPOSED

____S___

CO

WV

GV

× 98.9

BERGEN COUNTY SOIL CONSERVATION DISTRICT SOIL EROSION AND SEDIMENT CONTROL NOTES 1. All soil erosion and sediment control practices will be installed in accordance with the Standards

for Soil Erosion and Sediment Control in New Jersey (NJ Standards), and will be installed in

proper sequence and maintained until permanent stabilization is established. 2. Any disturbed area that will be left exposed for more than thirty (30) days and not subject to construction traffic shall immediately receive a temporary seeding and mulching. If the season prohibits temporary seeding, the disturbed area will be mulched with unrotted straw at a rate of 2 tons per acre anchored by approved methods (i.e. peg and twine, mulch netting, or liquid mulch

3. Immediately following initial disturbance or rough grading, all critical areas subject to erosion will receive a temporary seeding in combination with straw mulch or a suitable equivalent, at a rate of 2 tons per acre, according to the NJ Standards.

4. Stabilization Specifications: A. Temporary Seeding and Mulching:

Ground Limestone - Applied uniformly according to soil test recommendations. Fertilizer - Apply 11lbs. /1,000 sf of 10-20-10 or equivalent with

50% water insoluble nitrogen (unless a soil test indicates otherwise) worked into the soil a minimum of 4".

Seed - perennial ryegrass 100 lbs. /acre (2.3 lbs. /1,000 sf) or other approved

seed; plant between March 1 and May 15 or between August 15 and October 1. Mulch - Unrotted straw or hay at a rate of 70 to 90 lbs. /1,000 sf applied to achieve 95% soil surface coverage. Mulch shall be anchored by approved methods (i.e. peg and twine, mulch netting, or liquid mulch binder).

3. Permanent Seeding and Mulching: Topsoil - A uniform application to an average depth of 5", minimum of 4" firmed in place is required.

Ground Limestone - Applied uniformly according to soil test recommendations.

Fertilizer - Apply 11 lbs. /1,000 sf of 10-10-10 or equivalent with 50% water insoluble nitrogen (unless a soil test indicates otherwise) worked into the soil a minimum of 4".

Seed - Turf type tall fescue (blend of 3 cultivars) 350 lbs. /acre (8 lbs. /1,000 sf)

or other approved seed; plant between March 1 and October 1 (summer seeding requires irrigation)

Mulch - Unrotted straw or hay at a rate of 70 to 90 lbs. /1,000 sf applied to achieve 95% soil surface coverage. Mulch shall be anchored by approved methods (i.e. peg and twine, mulch netting, or liquid mulch binder).

5. The site shall at all times be graded and maintained such that all stormwater runoff is diverted to soil erosion and sediment control facilities.

6. Soil erosion and sediment control measures will be inspected and maintained on a regular

basis, including after every storm event. 7. Stockpiles are not to be located within 50' of a floodplain, slope, roadway or drainage facility.

The base of all stockpiles shall be contained by a haybale sediment barrier or silt fence. 8. A crushed stone, vehicle wheel-cleaning blanket will be installed wherever a construction access road intersects any paved roadway. Said blanket will be composed of 1" - 21/2" crushed stone, 6" thick, will be at least 30' x 100' and should be underlain with a suitable synthetic sediment

filter fabric and maintained. 9. Maximum side slopes of all exposed surfaces shall not exceed 3:1 unless otherwise approved

10. Driveways must be stabilized with 1" - 21/2" crushed stone or subbase prior to individual lot

construction. 11. All soil washed, dropped, spilled or tracked outside the limit of disturbance or onto public right-

of-ways, will be removed immediately. Paved roadways must be kept clean at all times. 12. Catch basin inlets will be protected with an inlet filter designed in accordance with Section 28 -1 of the NJ Standards.

13. Storm drainage outlets will be stabilized, as required, before the discharge points become 14. Dewatering operations must discharge directly into a sediment control bag or other approved

filter in accordance with Section 14-1 of the NJ Standards. 15. Dust shall be controlled via the application of water, calcium chloride or other approved method in accordance with Section 16-1 of the NJ Standards.

16. Trees to remain after construction are to be protected with a suitable fence installed at the drip line or beyond in accordance with Section 9-1 of the NJ Standards.

17. The project owner shall be responsible for any erosion or sedimentation that may occur below stormwater outfalls or off-site as a result of construction of the project.

18. Any revision to the certified Soil Erosion and Sediment Control Plan must be submitted to the District for review and approval prior to implementation in the field.

19. A copy of the certified Soil Erosion and Sediment Control Plan must be available at the project site throughout construction.

20. The Bergen County Soil Conservation District must be notified, in writing, at least 48 hours prior to any land disturbance: Bergen County SCD, 700 Kinderkamack Road, Suite 106, Oradell,


NJ 07649. Tel: 201-261-4407; Fax 201-261-7573. 21. The Bergen County Soil Conservation District may request additional measures to minimize

on or off-site erosion problems during construction. 22. The owner must obtain a District issued report of compliance prior to the issuance of any

certificate of occupancy. The District requires at least one week's notice to facilitate the scheduling of all report of compliance inspections. All site work must be completed, including temporary/permanent stabilization of all exposed areas, prior to the issuance of a report of compliance by the District.

Revised 12/7/17

COI	NSTRUCTION SEQUENCE (SITEWORK):	DURATION :
1.	CONSTRUCT STABILIZED CONSTRUCTION ENTRANCE.	1 DAY
2.	CONSTRUCT SILT FENCE.	1 DAY
3.	CLEAR SITE WITHIN LIMIT OF DISTURBANCE, STRIP AND STOCKPILE TOPSOIL AND GRADE SITE.	1 DAY
4.	EXCAVATE FOR FOUNDATION, SEEPAGE PITS AND SWIMMING POOL.	2 WEEKS
5.	CONSTRUCT BUILDING, SWIMMING POOL AND APPURTENANCES.	4 MONTHS
	CONSTRUCT ROOF DRAINS AND SEEPAGE PITS.	1 WEEK
7.	AFTER BUILDING IS COMPLETE, PERFORM FINAL GRADING, UNIFORMLY APPLY TOPSOIL TO AN AVERAGE DEPTH OF 5".	1 WEEK
	MINIMUM OF 4", FIRMED IN PLACE AND INSTALL LANDSCAPING.	
8.	CONSTRUCT BASE COURSE PAVEMENT AND FINAL PAVEMENT COURSE.	1 DAY
9.	REMOVE EROSION CONTROL DEVICES WHEN ALL DISTURBED AREAS HAVE BEEN STABILIZED.	1 DAY

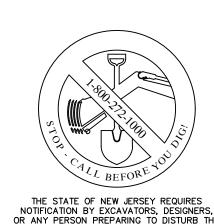

EARTH'S SURFACE ANYWHERE IN THE STATE

RES-A ZONE **ZONE** EVELAND **MUPUD** ZONE

PROPERTY KNOWN AS LOT 5 IN BLOCK 1304 AS SHOWN ON THE CURRENT TAX MAP SHEET 13, LAST REVISED APRIL 2003, OF THE BOROUGH OF NEW MILFORD.

PROPERTY OWNER/APPLICANT: 203 MAIN STREET PROPERTY LLC 725 RIVER ROAD

NEW MILFORD, NJ 07646

AREA OF ENTIRE PROPERTY: 12,848 S.F. or 0.2949 ACRES PROPERTY LOCATED IN THE B (BUSINESS) ZONING DISTRICT.

THE VERTICAL DATUM SHOWN HEREON IS BASED ON AN ASSUMED DATUM.

ITEM	REQUIRED	EXISTING	PROPOSED
USE - APARTMENT ON FIRST FLOOR *	NOT PERMITTED	N/A	YES♡
MIN. LOT AREA	5,000 S.F.	N/A	12,848 S.F.
MIN. FRONT YARD	0.0'	0.6'	0.8'
MIN. SIDE YARD	0.0'	0.1'	0.1'
MIN. REAR YARD	10.0'	11.7'	11.7'
MAX. IMPERVIOUS COVERAGE	100.0%	99.9%	99.4%
MAX. BUILDING HEIGHT			
(STORIES)	2-1/2	1	2
(FEET)	35.0'	16.8'	34.6'
MIN. SIZE OF RESIDENTIAL UNITS			_
(ONE-BEDROOM UNITS)	700 S.F.	N/A	655 S.F.₩
(TWO-BEDROOM UNITS)	900 S.F.	N/A	844 S.F.₩
MIN. PARKING SPACES			
(RESIDENTIAL / RESTAURANT)	20	19	20_
(RESIDENTIAL / RETAIL)	26	19	20🖤
O DENOTED VARIANCE REQUIRER		•	•

* FOR LOTS <1.0 ACRE - PER § 30-25.1(A)(11)

RESTAURANT PARKING CALCULATION PER NEW MILFORD ZONING (§ 30-28.1(E)): ONE (1) SPACE PER 4 SEATS = 32 SEATS / 4 = 8 PARKING SPACES REQUIRED

RETAIL PARKING CALCULATION PER NEW MILFORD ZONING (§ 30-28.1(E)):

ONE (1) SPACE PER 150 S.F. = 1,976 S.F. / 150 S.F. = 13.17; USE 14 PARKING SPACES REQUIRED RESIDENTIAL PARKING CALCULATION PER RSIS (N.J.A.C. 5:21 TABLE 4.4):

5 - TWO (2) BEDROOM APARTMENTS @ 2.0 SPACE EACH = 10 PARKING SPACES

1 - ONE (1) BEDROOM APARTMENTS @ 1.8 SPACE EACH = 2 PARKING SPACES PARKING SPACES REQUIRED = 12 PARKING SPACES

ARE SUBJECT TO FINAL APPROVAL BY THE RESPECTIVE UTILITY PROVIDERS. LOCATION & INVERT OF EXISTING SANITARY SEWER MAIN TO BE VERIFIED IN FIELD PRIOR

TO COMMENCEMENT OF CONSTRUCTION.

A SOIL LOG AND PERCOLATION TEST SHALL BE CONDUCTED AT THE LOCATION OF THE PROPOSED SEEPAGE PITS. THE BOROUGH ENGINEER MUST BE CONTACTED AT LEAST 48 HOURS BEFORE THE TEST IS SCHEDULED, AND TEST RESULTS MUST BE FURNISHED TO THE BUILDING DEPARTMENT & THE BOROUGH ENGINEER PRIOR TO ISSUANCE OF A BUILDING PERMIT.

ACTUAL LOCATIONS OF WATER, GAS, ELECTRIC, TELEPHONE AND CABLE SERVICE CONNECTIONS

SEEPAGE PIT SHALL BE INSPECTED ONCE PER YEAR AND AFTER EACH RAINFALL EVENT OF 1" PRECIPITATION PER 24 HOUR PERIOD. ANY BUILDUP OF LEAVES OR DEBRIS SHALL BE REMOVED

IN ACCORDANCE WITH THE MANUFACTURER'S RECOMMENDATIONS. OVERFLOW TEE CONNECTIONS AND SPLASH BLOCKS TO BE INSTALLED AT ALL ROOF LEADER

DRAIN DOWNSPOUTS.

ALL ROOF LEADER DRAINS SHALL BE CONNECTED TO THE SEEPAGE PITS. THE DEVELOPER MUST TAKE CAUTION WHEN COMPLETING THE FINAL GRADING SO AS NOT TO

CAUSE INCREASE RUNOFF ONTO ADJACENT PROPERTIES. ALL CONSTRUCTION TO BE IN ACCORDANCE WITH THE BOROUGH'S ORDINANCES AND/OR

ALL CURB & ROADWAY DAMAGED DURING CONSTRUCTION TO BE REPLACED TO BOROUGH

APPLICANT GRANTS BOROUGH OFFICIALS AND EMPLOYEES PERMISSIONS TO ENTER PROPERTY FOR THE PURPOSE OF SURVEYS/INSPECTIONS.

ate: 5-11-21 Description: Per Revised Architectural Plans

SITE PLAN AND SOIL EROSION & SEDIMENT CONTROL PLAN

Prepared For

203 MAIN STREET PROPERTY LLC

203 MAIN STREET

Block 1304 - Lot 5 Borough of New Milford Bergen County New Jersey




Azzolina & Feury Engineering Inc. PROFESSIONAL ENGINEERS AND LAND SURVEYORS Madison Avenue, Paramus, NJ 07652 - (201) 845-8500 - Fax (201) 845-3825

110 Stage Road, Monroe, NY 10950 - (845) 782-8681 - Fax (845) 782-4212 N.J. CERTIFICATE OF AUTHORIZATION

24GA28003600




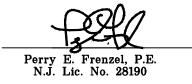


Date: 4-20-21 Drawn By: CDD Scale: 1" = 20'

Dwg. No. 1 of 2

Checked By: PEF Job No.: 12061

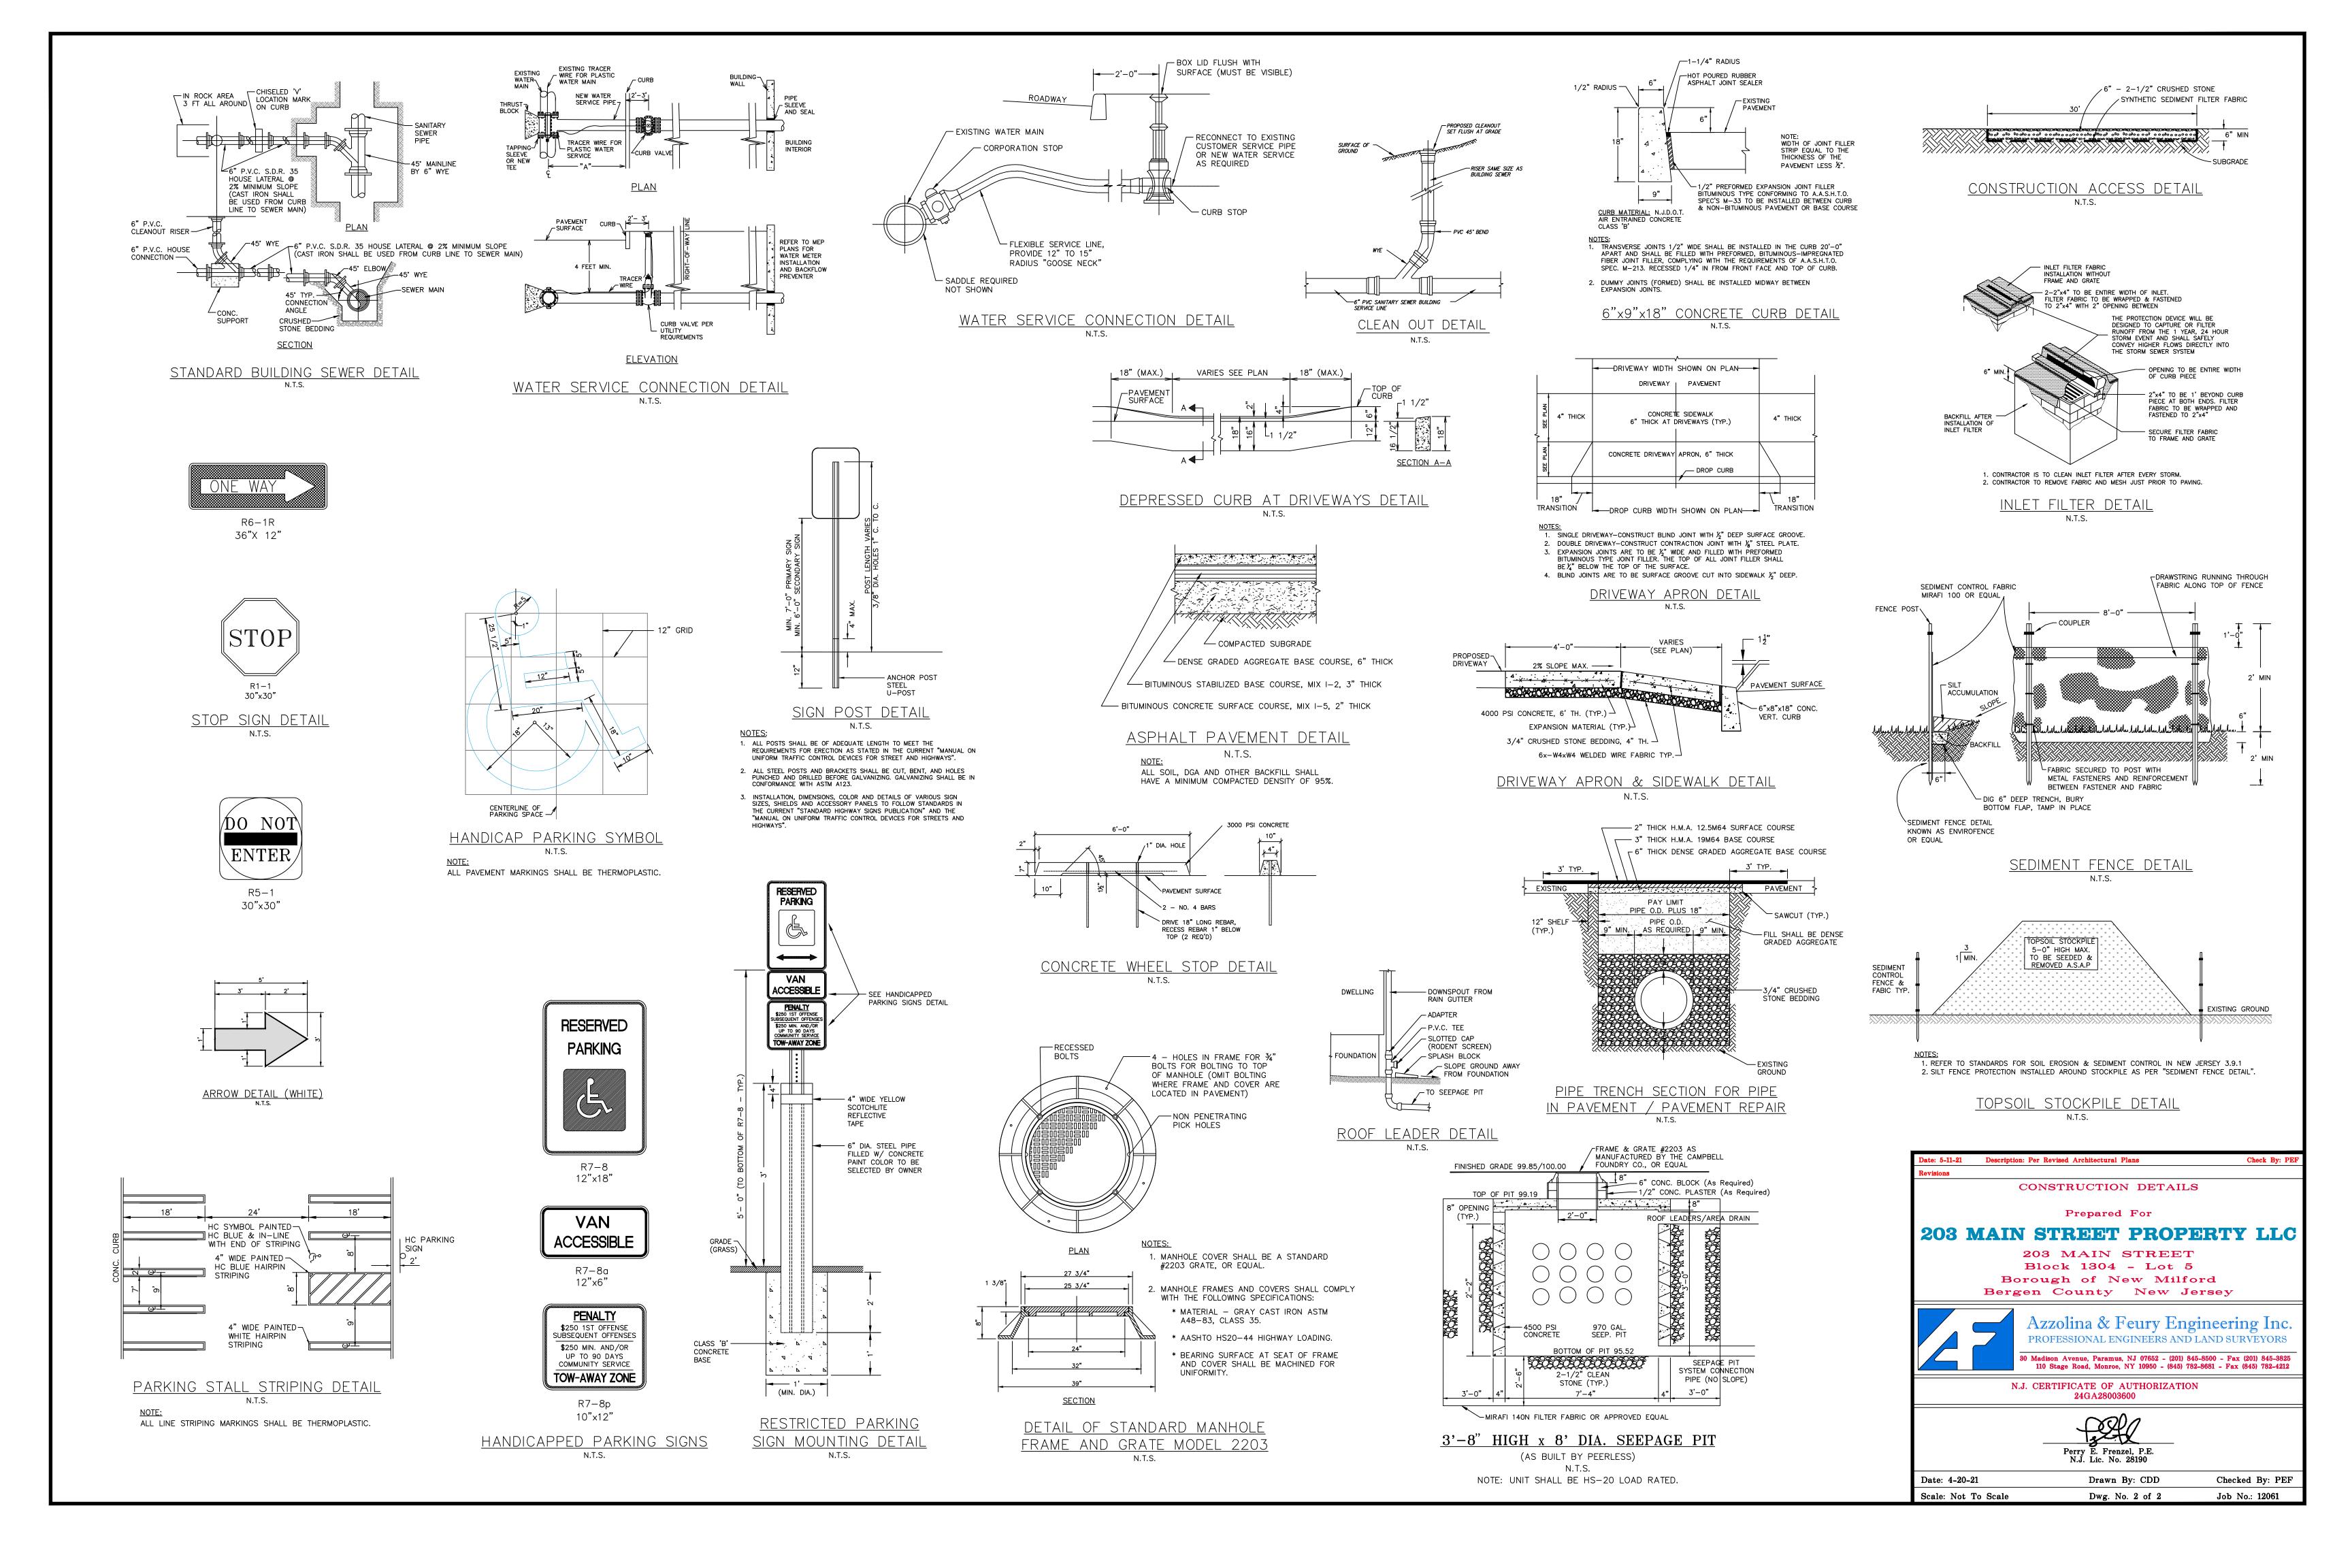



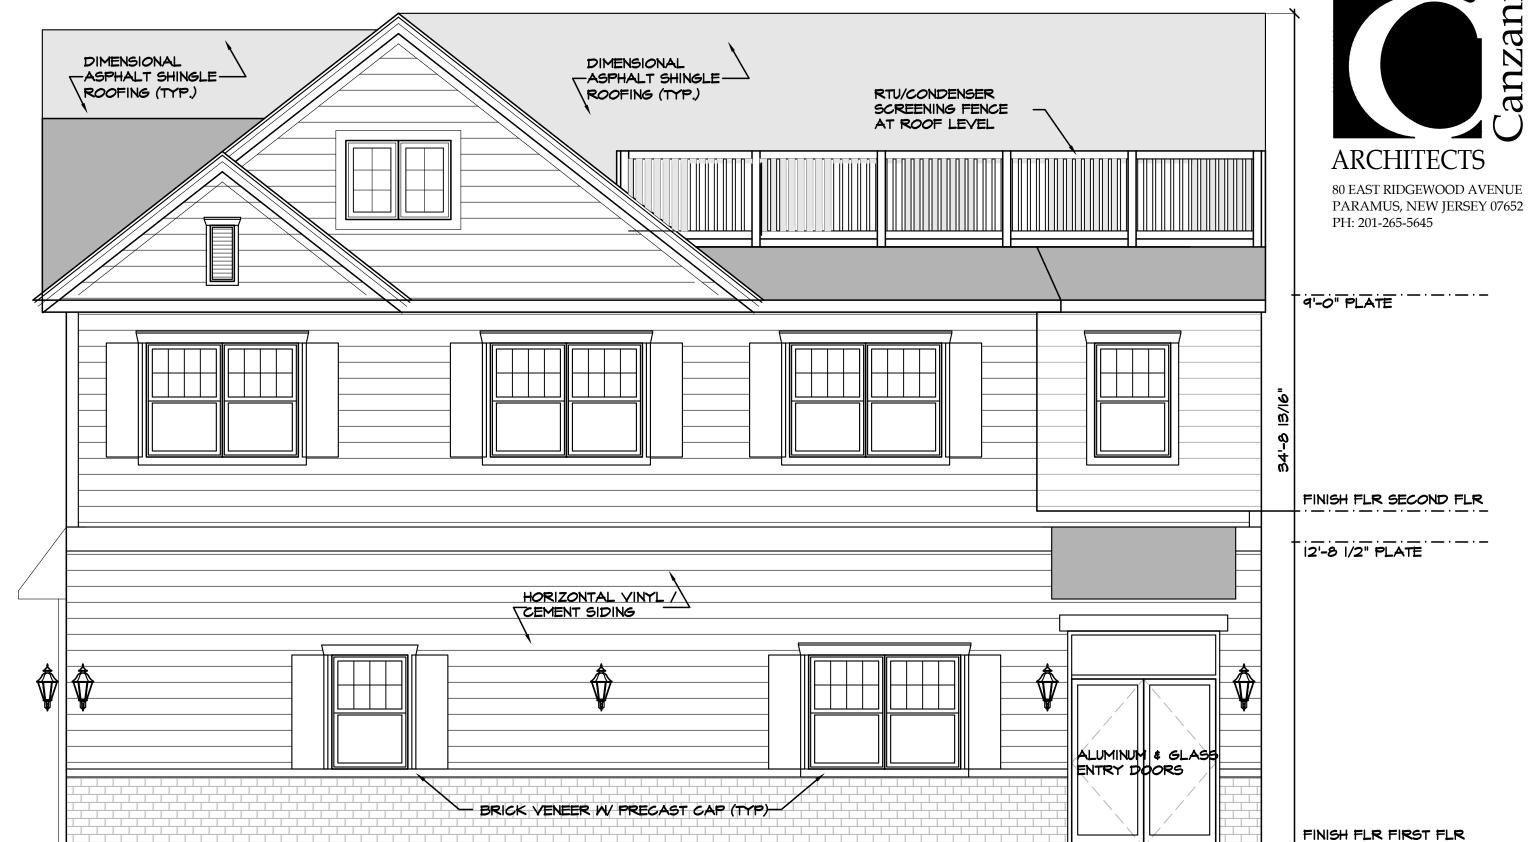

FRONT ELEVATION
SCALE 1/4" = 1'-0"


REAR ELEVATION

SCALE 1/4" = 1'-0"




SIDE ELEVATION

SCALE 1/4" = 1'-0"

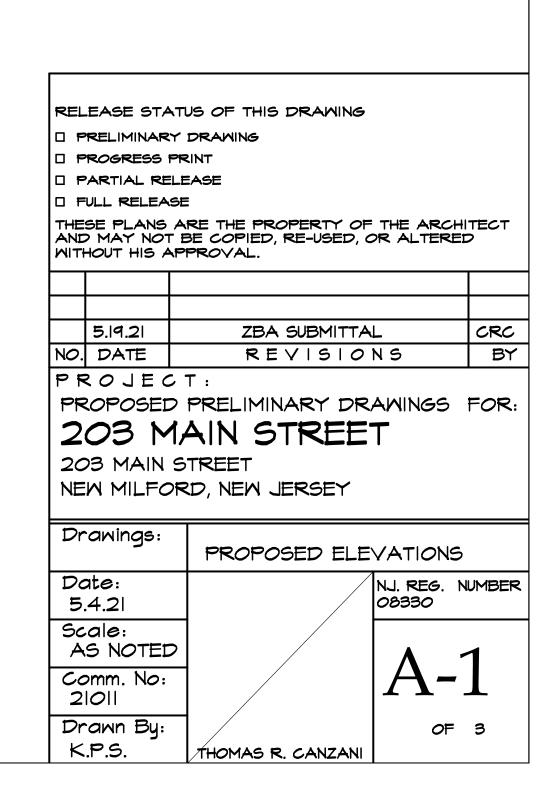



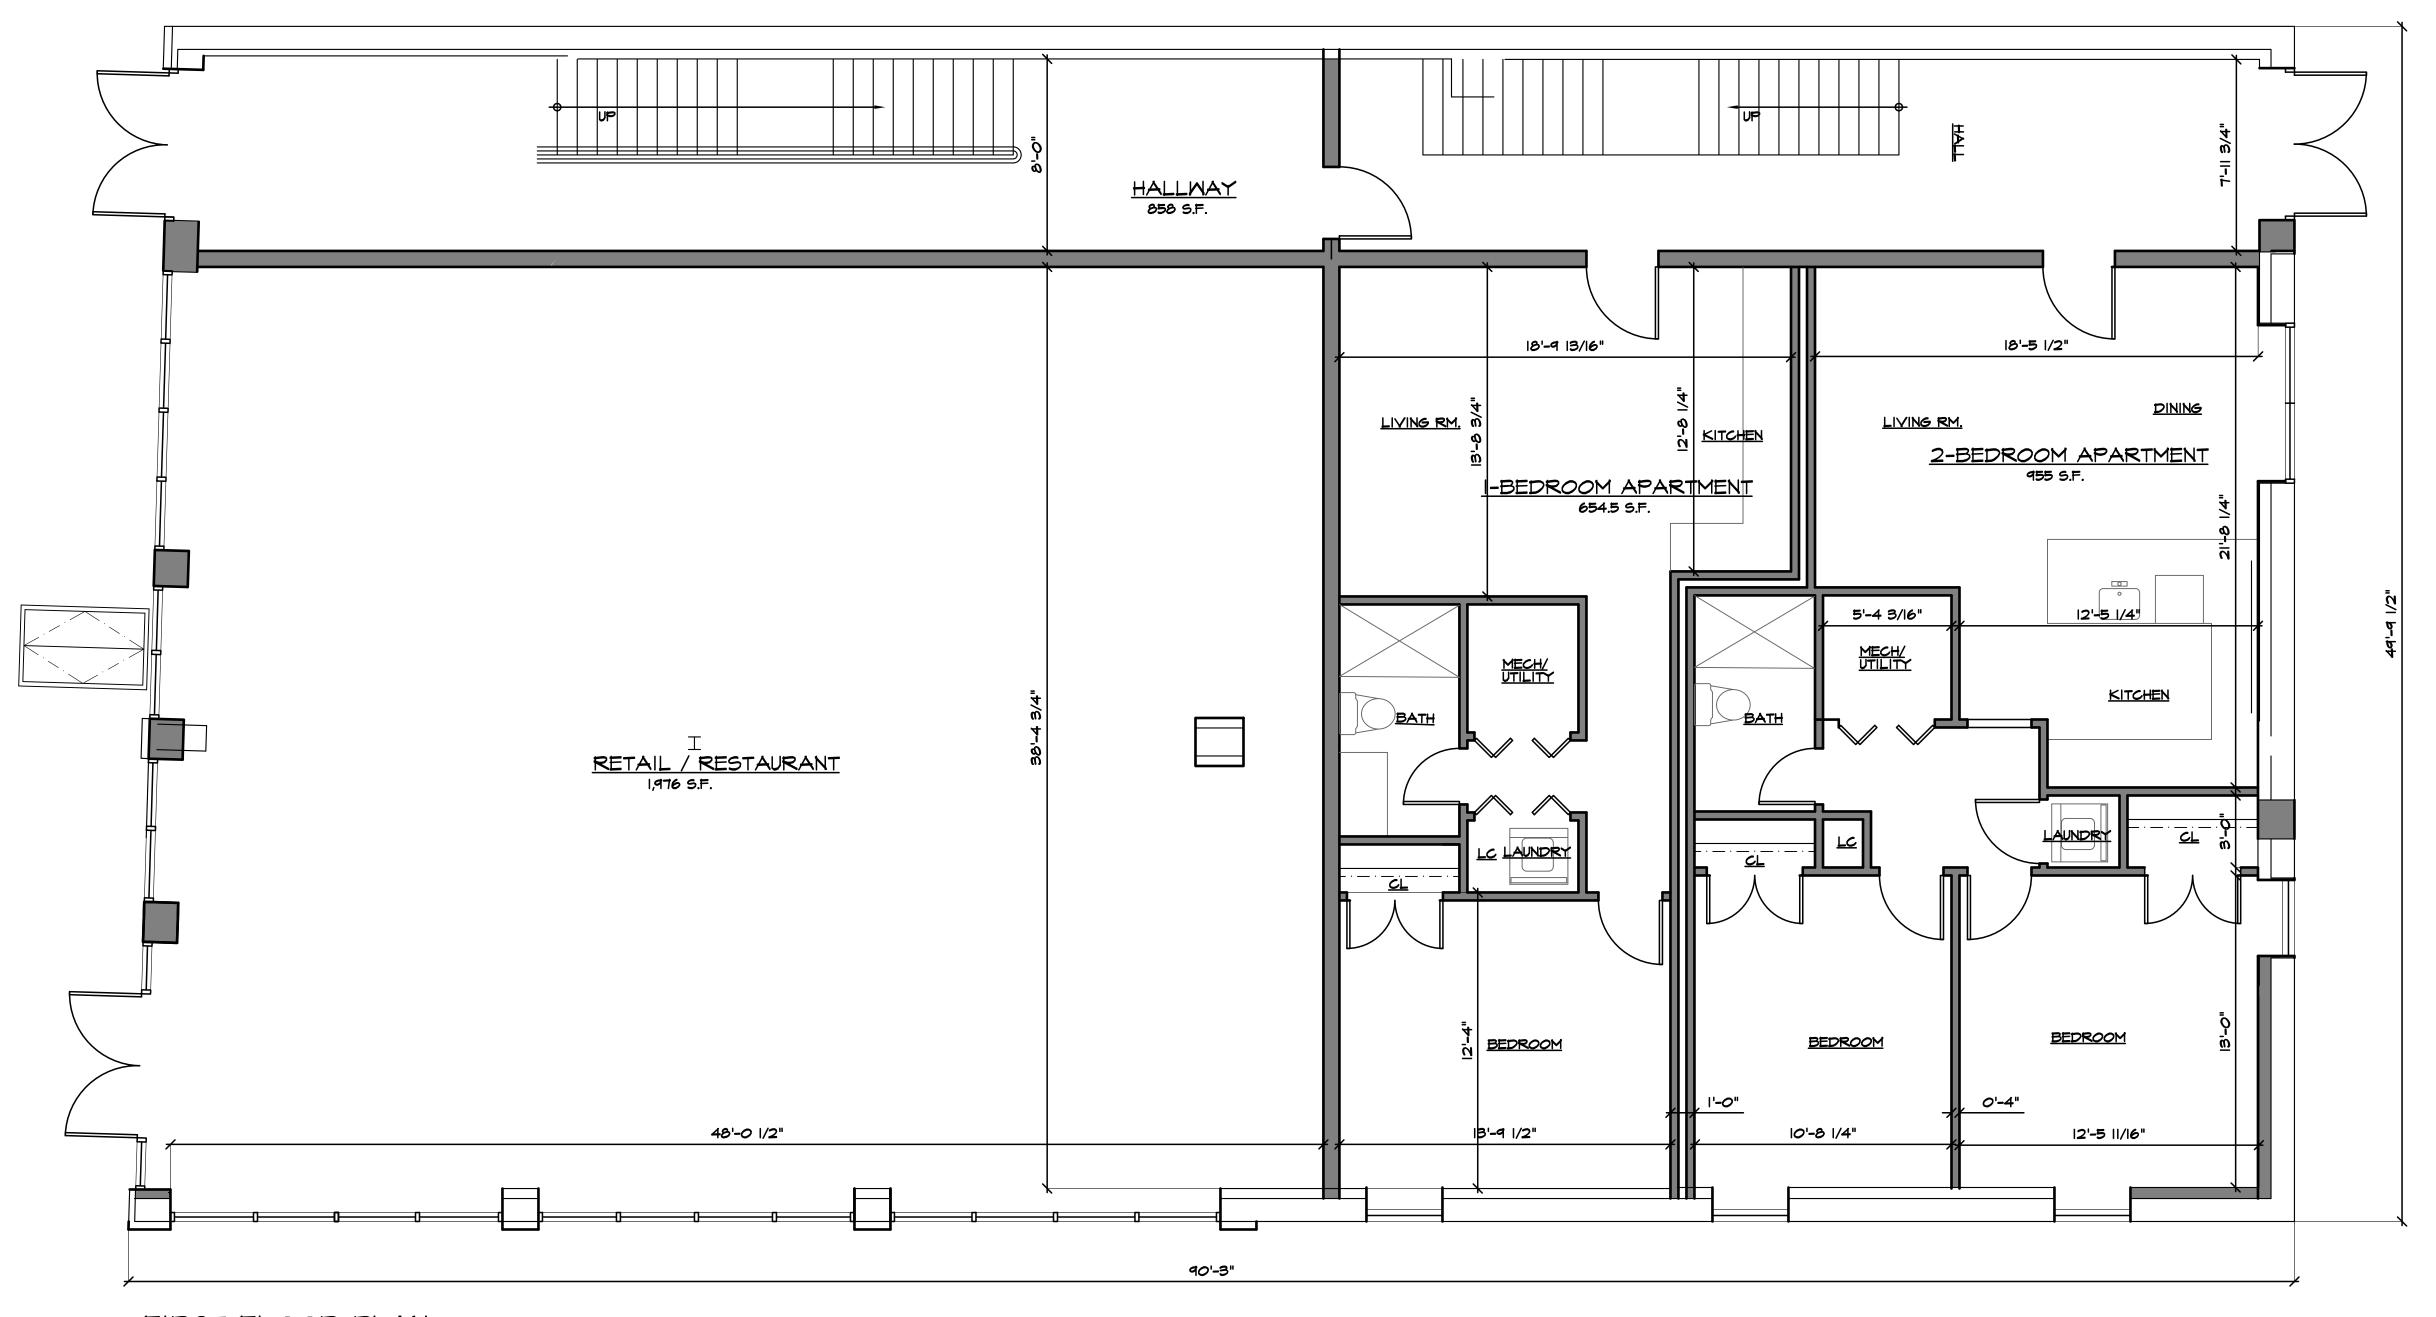

FIRST FLOOR PLAN
SCALE 1/4" = 1'-0"

RETAIL/RESTAURANT: I-BED APARTMENT: 1,976 S.F. 654.5 S.F. 955 S.F. 858.0 S.F. 2-BED APARTMENT:

TOTAL Ist FLOOR AREA: 4,443.5 S.F.

RELEASE STATUS OF THIS DRAWING

☐ PRELIMINARY DRAWING

☐ PROGRESS PRINT ☐ PARTIAL RELEASE

☐ FULL RELEASE

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	5.19.21	ZBA SUBMITTAL	CRC
NO.	DATE	REVISIONS	BY

PROJECT:


PROPOSED PRELIMINARY DRAWINGS FOR:

203 MAIN STREET

203 MAIN STREET NEW MILFORD, NEW JERSEY

Drawings:	PROPOSED PLA	NS
Date: 5.4.21		NJ. REG. NUMBER 08330
Scale: AS NOTED		A O
Comm. No: 21011		A-2
Drawn By: K.P.S.	THOMAS R. CANZANI	<i>o</i> ⊧ 3



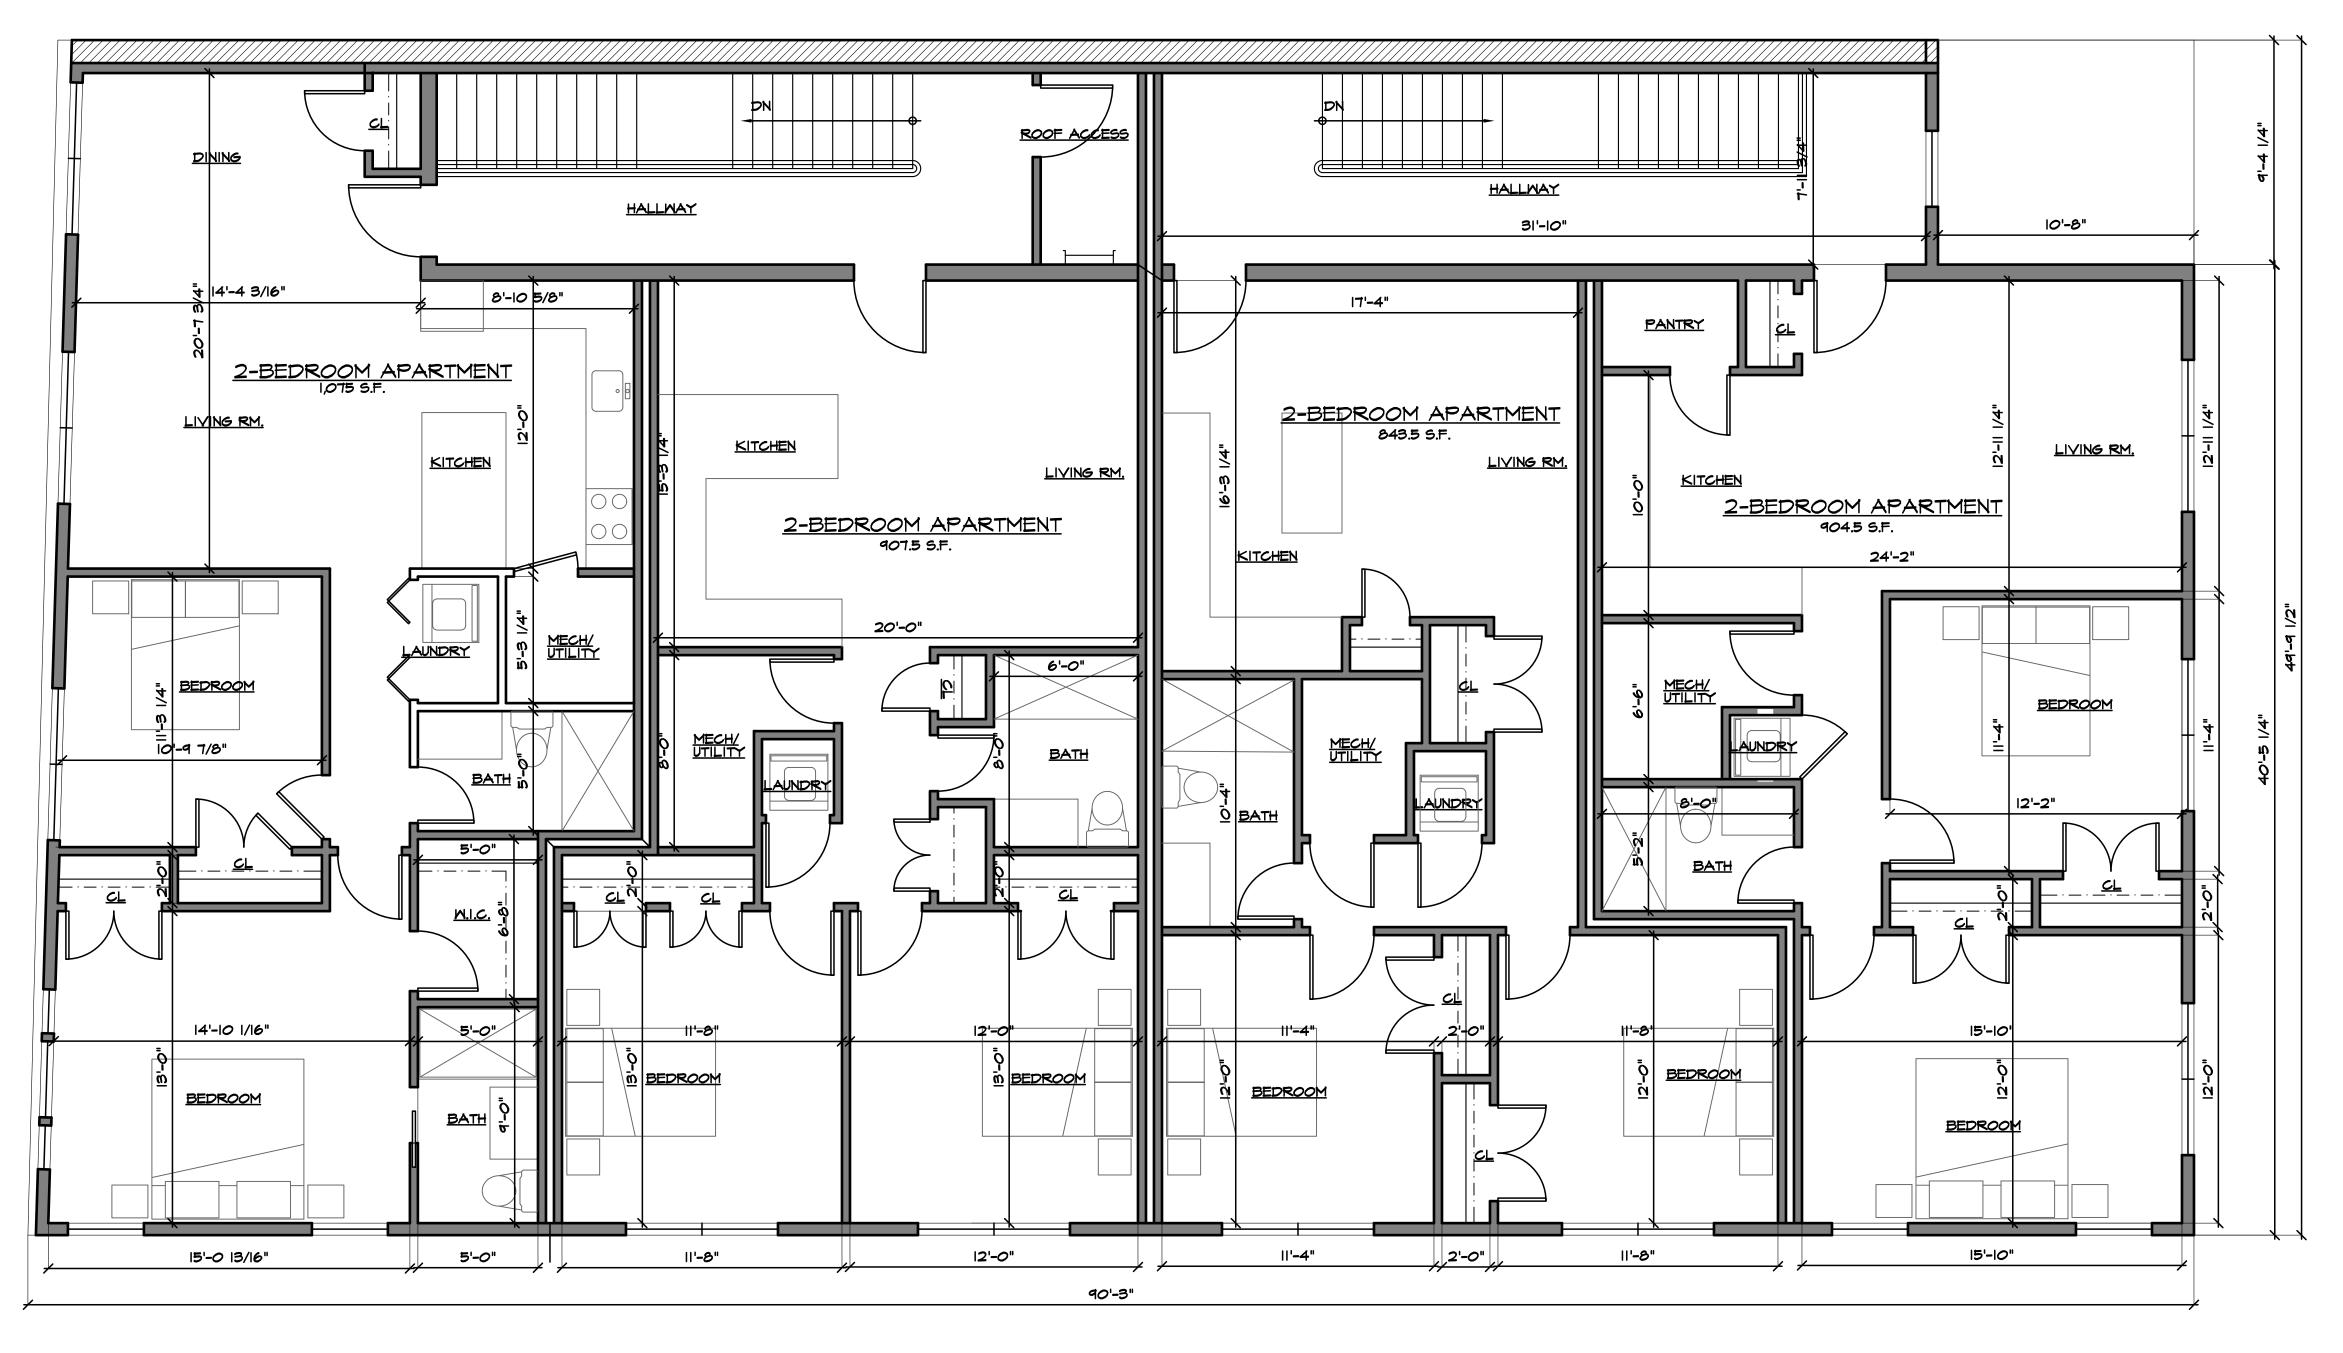

SECOND FLOOR PLAN SCALE 1/4" = 1'-0"

2-BED APARTMENT: 1,075 S.F. 2-BED APARTMENT: 843.5 S.F. 2-BED APARTMENT: 907.5 S.F. 2-BED APARTMENT: 904.5 S.F. 291.0 S.F. 318.0 S.F. TOTAL : TOTAL : 2,066 S.F. 2,273.5 S.F. 4,339.5 S.F. TOTAL 2ND FLOOR AREA :

RELEASE STATUS OF THIS DRAWING

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	5.19.21	ZBA SUBMITTAL	CRC
NO.	DATE	REVISIONS	BY
		· -	

PROJECT:

PROPOSED PRELIMINARY DRAWINGS FOR:

203 MAIN STREET

203 MAIN STREET

NEW MILFORD, NEW JERSEY

Drawings:	PROPOSED PLA	NS
Date: 5.4.2		NJ. REG. NUMBER 08330
Scale: AS NOTED		A 2
Comm. No: 21011		A-3
Drawn By: K.P.S.	THOMAS R. CANZANI	<i>o</i> f 3