

LOT COVERAGE								
Lot Area	11,736							
Item	Existing (sf)	Proposed (sf)	Variance					
House	2,339	2,339						
Shed	98	98						
Driveway	791	791						
Front Walk	144	144						
Rear Patio/Walks	379	397						
A/C Pads & Generator	27	27						
Prop. Pool/Coping		821						
Prop. Pool Patio		653						
Equip Pads		21						
	2,437	2,437	Ex. Non-					
Max. Building Coverage	20.8%	20.8%	Conforming					
Max. Impverious Coverage	3,778	5,291	Yes					
iviax. iiiipveiious coverage	32.2%	45.1%						

Cut/Fill Summary


LEGEND

Proposed Spot Elevation


x 87.65 Existing Spot Elevation

----- Existing Contour

Name	Cut Factor	Fill Factor	2d Area	Cut	Fill	Net
Cut_Fill	1.000	1.000	935.64 Sq. Ft.	49.35 Cu. Yd.	5.50 Cu. Yd.	43.85 Cu. Yd. <cut></cut>
Totals			935.64 Sq. Ft.	49.35 Cu. Yd.	5.50 Cu. Yd.	43.85 Cu. Yd. <cut></cut>

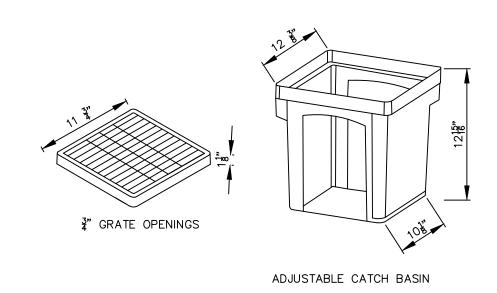

12" CATCH BASIN DETAIL NTS by NDS OR EQUAL

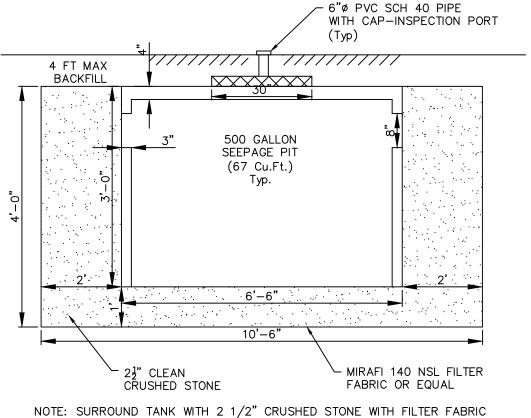


MIRAFI 140 NSL OR EQUAL.

SEEPAGE TANK DETAIL

NTS by PEERLESS OR EQUAL

PROVIDED: 1-500 GAL DRY WELL = 67 cu.ft. STONE STORAGE (40% VOIDS): Pit Volume: $10.5' \times 10.5' \times 4' = 441 \text{ cu.ft.}$ 0.D. $Tank=(3.14)(3.25)^2(3)=99.5$ cu.ft. 441 cu.ft.-99.5 cu.ft.=341.5 cu.ft. @ 40% voids=137 cu.ft. TOTAL STORAGE =137 cu.ft+67 cu.ft.=204 cu.ft.

Stormwater Calculations: Proposed Pool/Patio=1,474 sf Criteria: NJ Water Quality Storm (1.25") $1,474 \text{ sf } \times 1.25$ "=154 cu.ft.

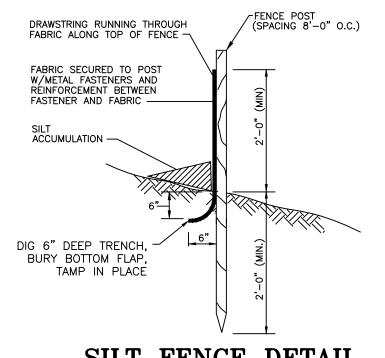

- PROVIDE APPROPRIATE TRANSITION BETWEEN STABILIZED CONSTRUCTION ENTRANCE AND PUBLIC OR PRIVATE R.O.W. OR STREET. -8" MINIMUM LAYER - SEE NOTE 2 FILTER FABRIC LINER SECTION NOTES:

1. PLACE STABILIZED CONSTRUCTION ENTRANCE AT LOCATION

2. STONE SIZE SHALL BE ASTM C-33, SIZE NO. 2 OR 3, CLEANED CRUSHED ANGULAR STONE.


3. THE THICKNESS OF THE STABILIZED CONSTRUCTION ENTRANCE SHALL NOT

BE LESS THAN 8".


WIDTH - NOT LESS THAN FULL WIDTH OF POINTS OF INGRESS OR EGRESS.


THE STABILIZED CONSTRUCTION ENTRANCE SHALL BE MAINTAINED IN A CONDITION WHICH WILL PREVENT TRACKING OR FLOWING OF SEDIMENT ONTO THE R.O.W./PAVEMENT. THIS REQUIRES PERIODIC TOP DRESSING WITH ADDITIONAL STONE OR ADDITIONAL LENGTH AS CONDITIONS DEMAND AND REPAIR AND/OR CLEANOUT OF ANY MEASURE USED TO TRAP SEDIMENT 6. ALL SEDIMENT SPILLED, DROPPED, WASHED OR TRACKED ONTO THE PUBLIC ROADWAY MUST BE REMOVED IMMEDIATELY.


TRACKING PAD DETAIL

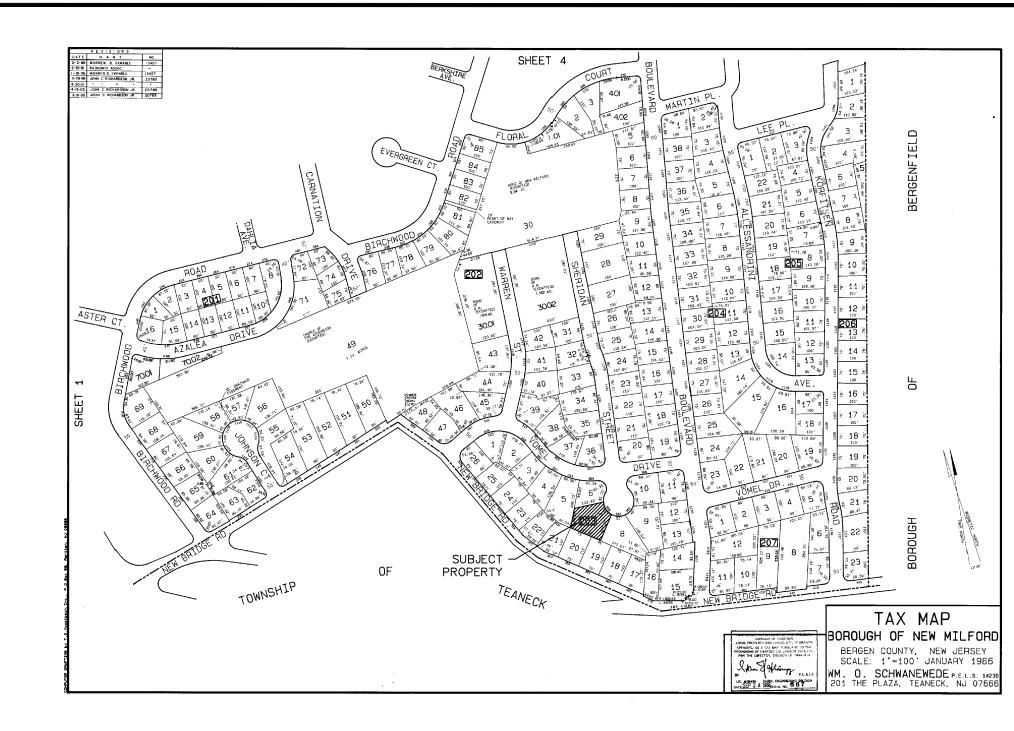

AREA MAP

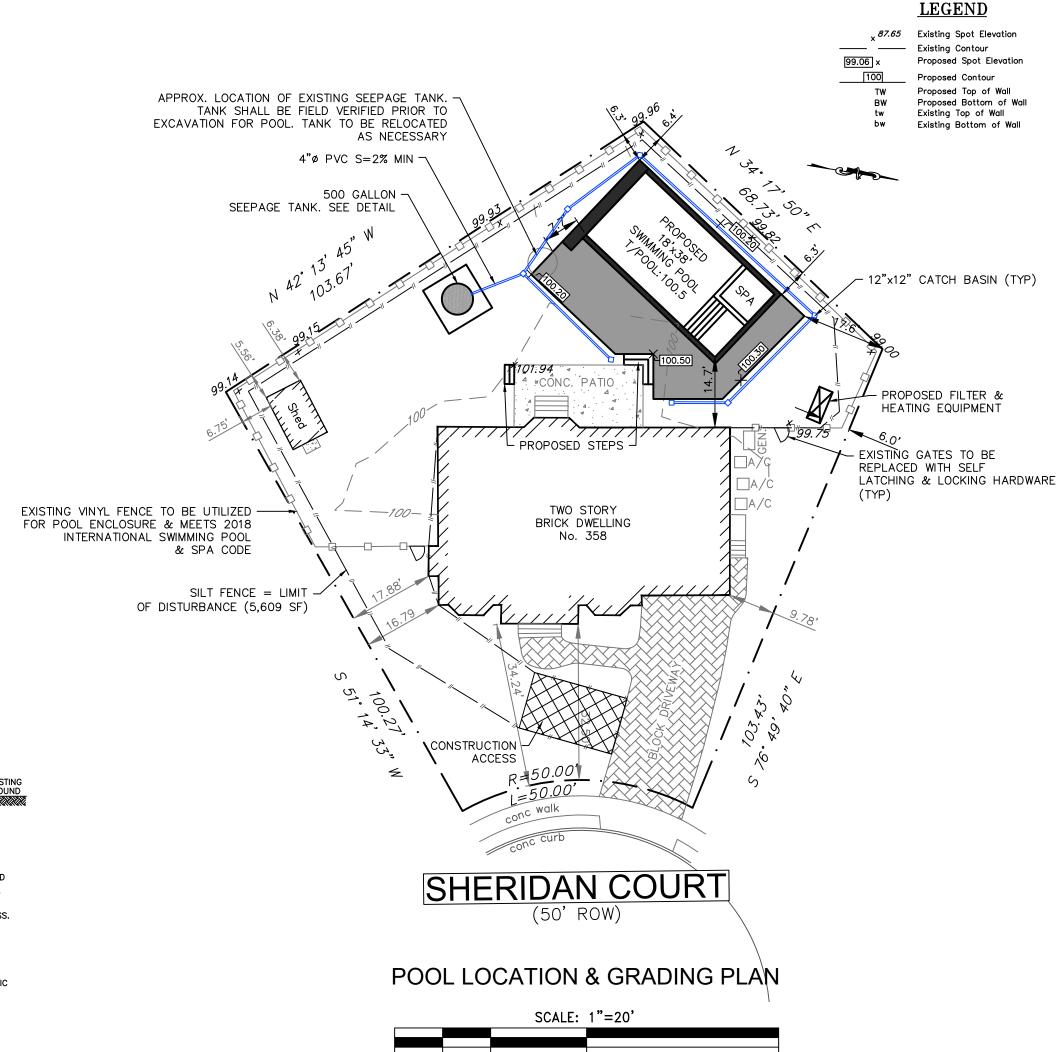

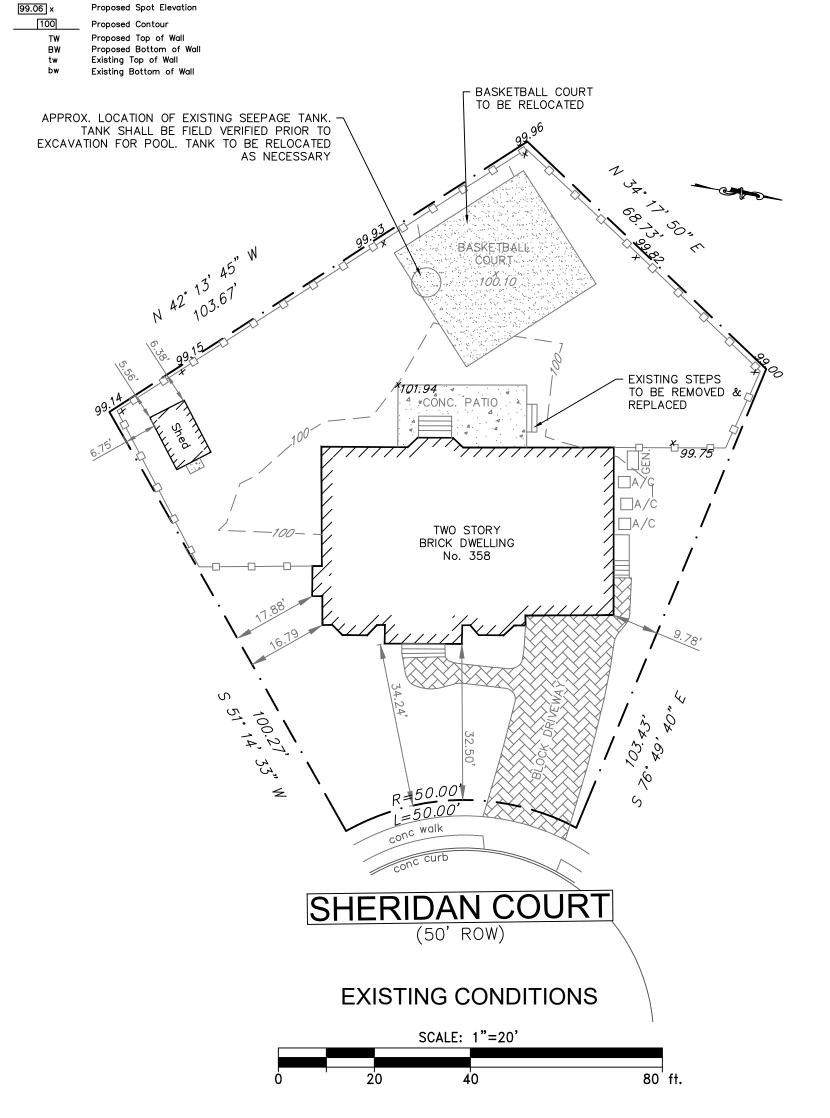

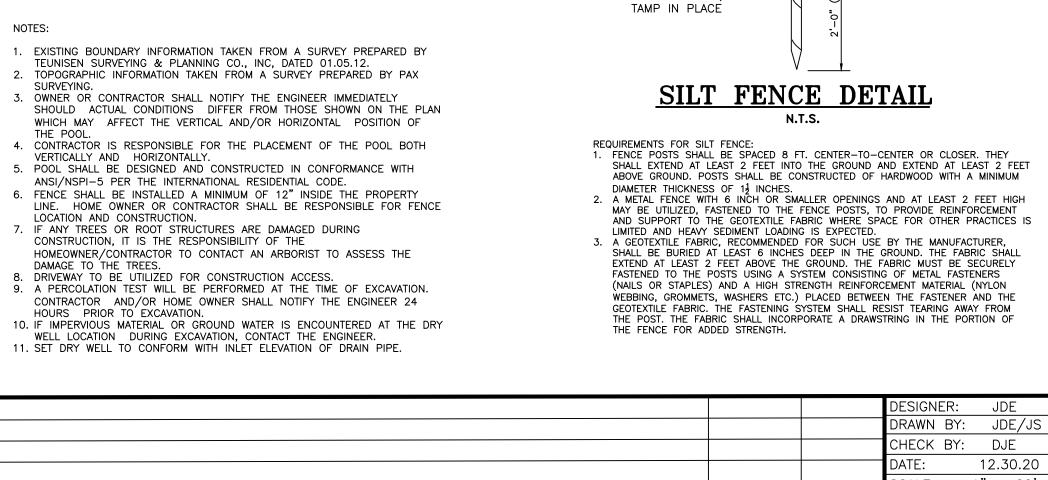

REVISION

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POOL LOCATION & GRADING PLAN FOR THE WALLACH RESIDENCE 358 SHERIDAN COURT

BLOCK 203 LOT 7

BOROUGH OF NEW MILFORD, BERGEN COUNTY, NJ SHEET 1 OF 1

DRAWING NO:

N.J. LIC. NO. 24GE02622900

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12.30.20 1" = 20'SCALE: PROJECT NO.: 20424 DATE APPROVED

DAVID J. EGARIAN, P.E.